DESIGN PHILOSOPHY


The Independent Living Units

The ILU's have generally been located as per the master plan. The units are a result of intensive market research and provide for duplex and apartment living with an abundant range of accessible living choices within the both types.

The ILU housing has been carefully located so as to consider visual impact with the walk up apartments contained within the area of low visibility and duplexes to mid level visibility.

The Apartments have underground parking to create an on ground garden setting conducive to disabled access and conductivity throughout the individual blocks and beyond to all areas up the Clubhouse etc.. The upper penthouse level is recessed from the floors below within cliplok walls folded down from the flat cliplok roof. This has the effect of lessening the visual bulk by an illusion of being contained within a mansard roof.

Variations in colour palette and materials for both Duplexes and Apartments assist in individualizing each block from its neighbour. Note that particular attention has been given to the Apartments overall southern elevation to individualise them when viewed from the downhill. This has been achieved by differing colour feature walls, contrasting broadwalls and variations in colour to privacy louvers. Note that varied extensive planting is proposed to the individual blocks to add and assist in the intent outlined above.

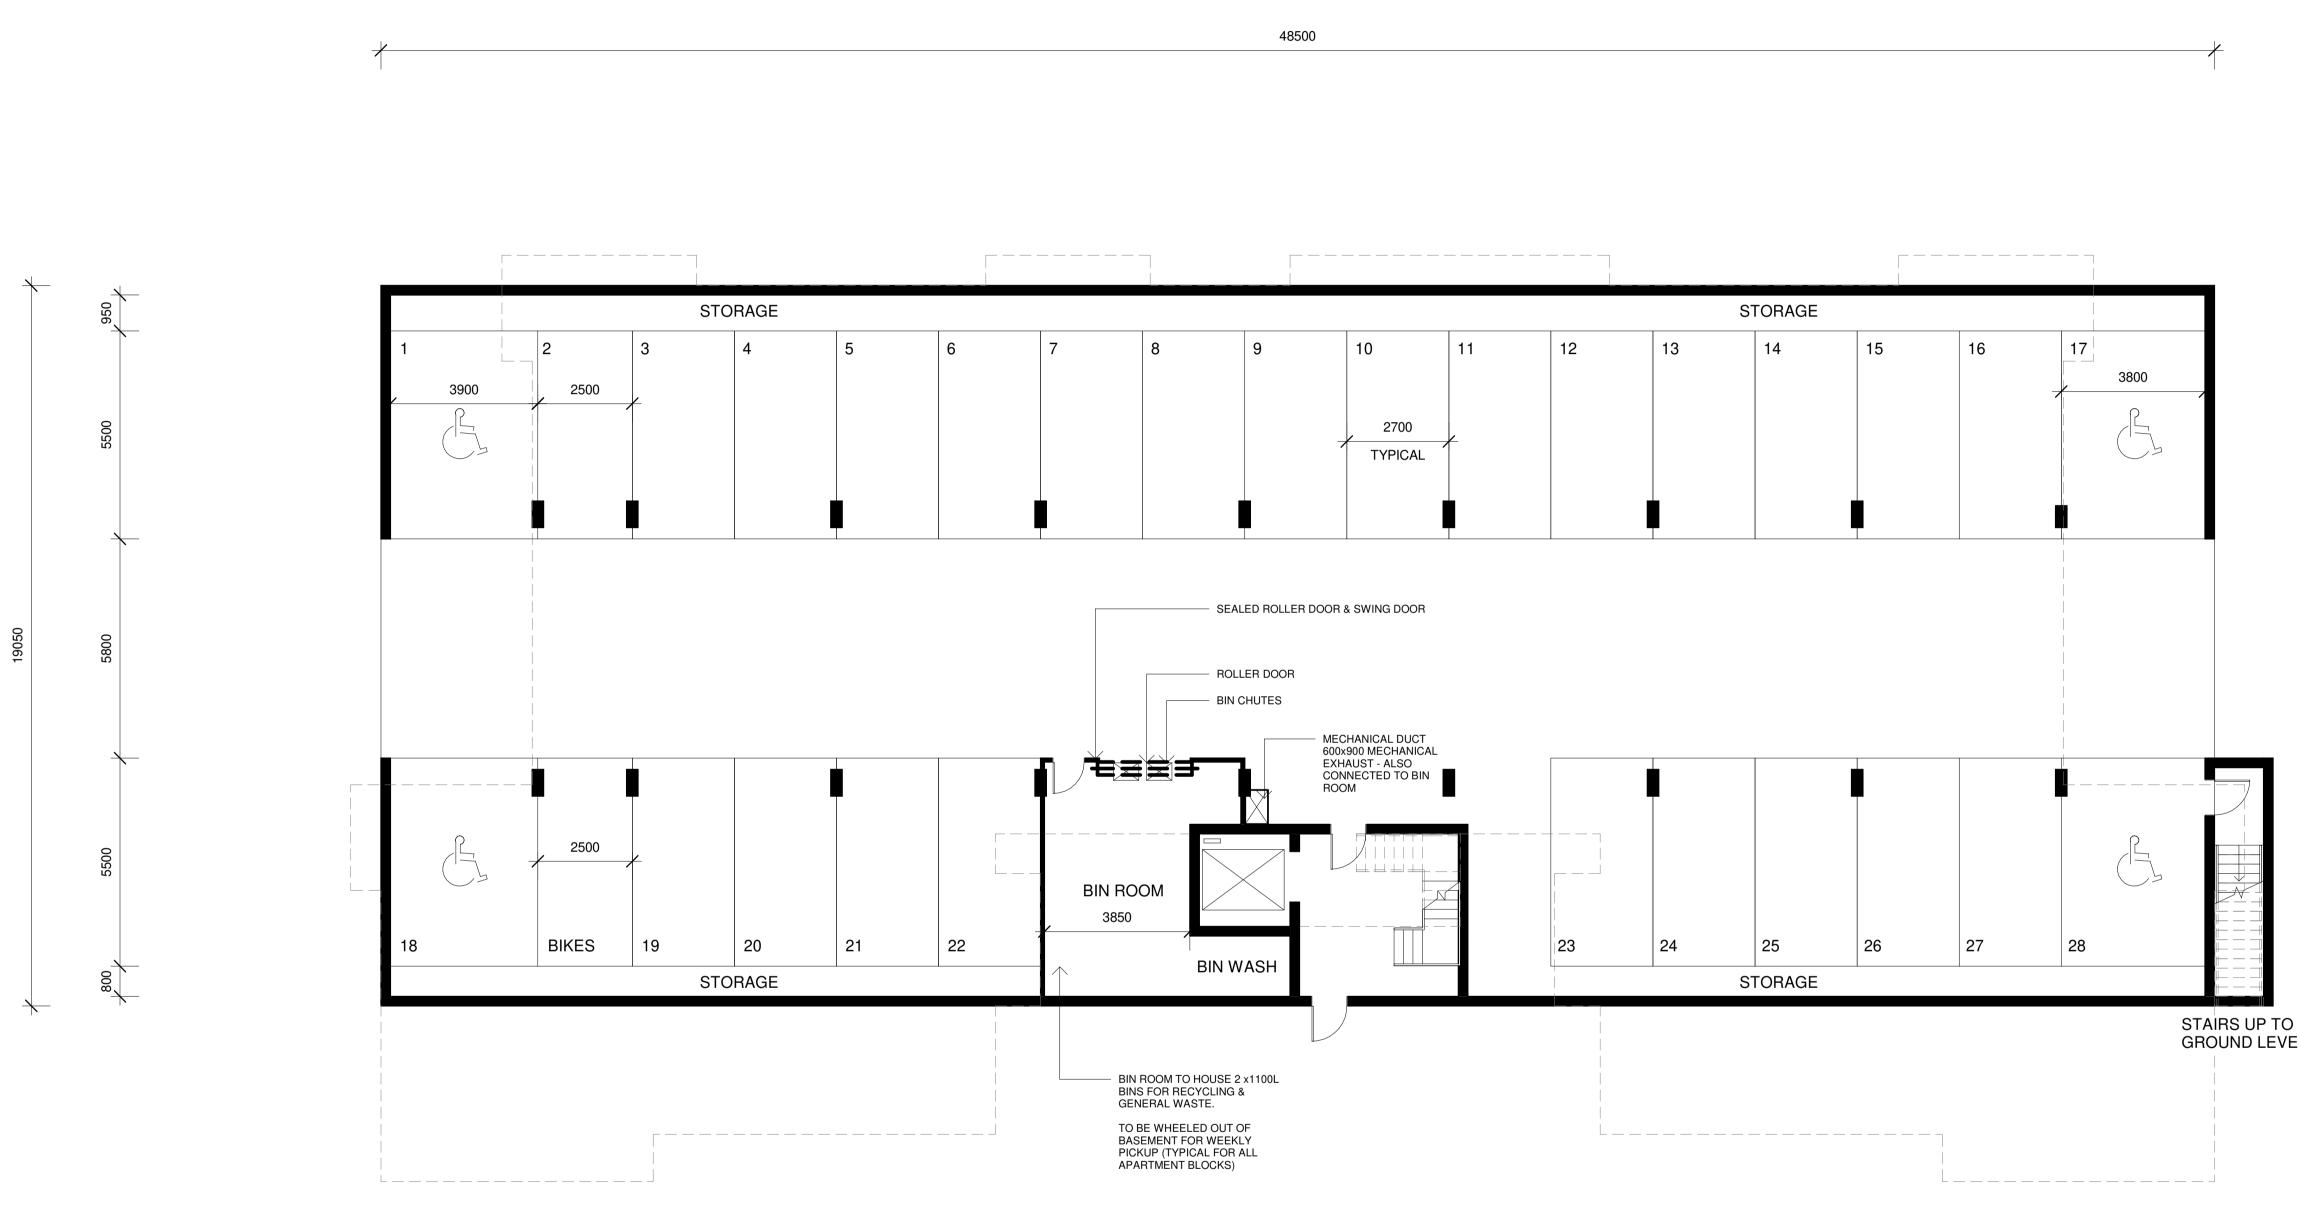

1	BASEMENT	
\bigcirc	1 : 100	

NOTE: ALL UNITS MEET COMPLIANCE GUIDELINES OF BOTH THE APARTMENT DESIGN GUIDE AND ACCESSIBILITY CONTROLS

DEVELOPMENT STATISTICS	
SITE AREA: 14.88 ha	
APARTMENTS - 133 UNITS:	
GROUND & LEVEL 1 = 675 sq.m x 2 =	1350 sq.m
LEVEL 2 =	470 sq.m (Represents 70% of footprint below)
TOTAL = 1820 sq.m Each x 7 Blocks	
MIX = 42 x 3br,2bth Units ; 56 x 2br,2bth Units ; 1	4 x 2br,2bth & 21 x 1br,1bth Units (133 total)
TOTAL: 133 Units with 231 Bathrooms	12,740 sq.m

GROUND LEVEL



А	09.05.2017	DEVELOPMENT APPLICATION SET
NO.	DATE.	DETAILS.
Amendr	nents:	

- Stephen Jones Associates
- p. 02 9977 2240
- m. 0418 866 784
- sj@stephenjonesassociates.com е.
- w. www.stephenjonesassociates.com


Registered Architect Gary Finn No. 5774 (NSW)

SENIORS LIVING DEVELOPMENT LOT 1, DP 780801 WINDWARD WAY, MILTON NSW 2538

APARTMENTS – TYPICAL BASEMENT PLAN

Scale: As indicated@A1 Job No: 1516 Date: 09.05.2017

Drawing No: **DA37**

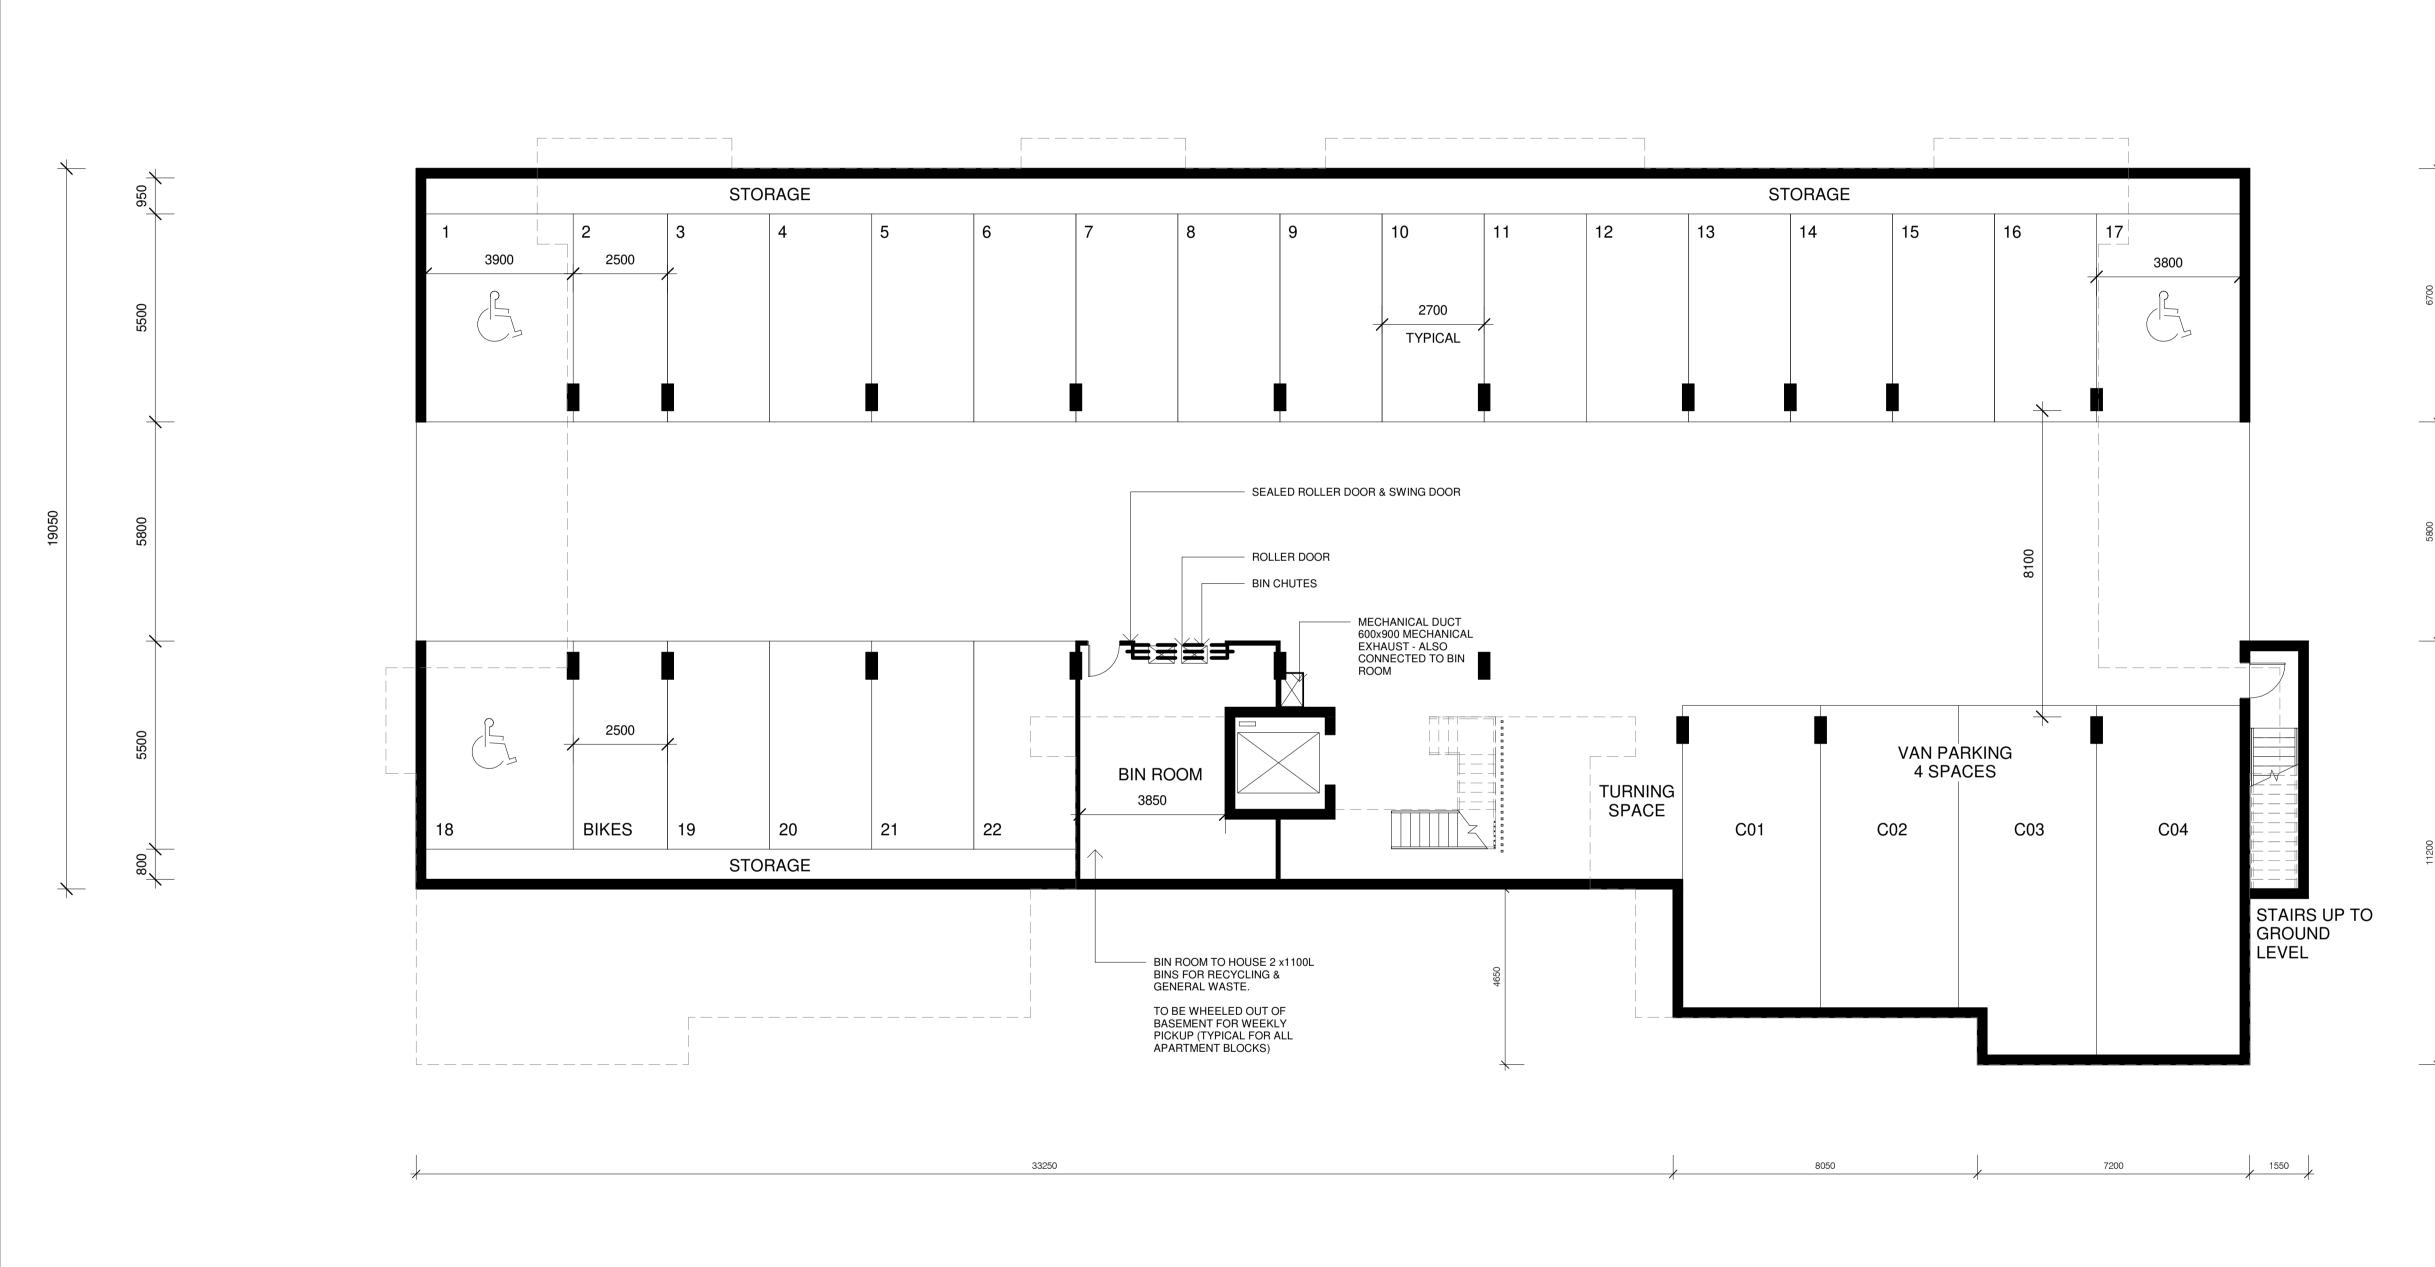







NOTE: ALL UNITS MEET COMPLIANCE GUIDELINES OF BOTH THE APARTMENT DESIGN GUIDE AND ACCESSIBILITY CONTROLS

NOTE: VAN SPACES (X4) PROPOSED 3.5M WIDE BY 8 TO 9.5 LENGTH.

NOTE ALSO AISLE REDUCED FROM RECOMMENDED 9M TO 7.8M AS PER ABOVE BY SUPPLIER OF 'AUSSIEWHEEL' ELECTRONIC CARAVAN MOVER (DOLLIES) WITH REGARDS TO ACHIEVABLE MANEUVÉRING WITH STANDARD NUMBER OF MOVEMENTS

В	10.09.2019	ADDITIONAL INFORMATION
A	09.05.2017	DEVELOPMENT APPLICATION SET
NO.	DATE.	DETAILS.

Stephen Jones Associates

- p. 02 9977 2240
- m. 0418 866 784
- sj@stephenjonesassociates.com e. w. www.stephenjonesassociates.com

Registered Architect Gary Finn No. 5774 (NSW)

Project: SENIORS LIVING DEVELOPMENT LOT 1, DP 780801 WINDWARD WAY, MILTON NSW 2538

Drawing: **APARTMENTS – BASEMENT PLAN** ALTERNATE

Scale: 1:100 @A1 Job No: 1516 Drawing No: Date: 10.09.2019








1:100


FLOOR AREA: 670 SQM

NOTE: ALL UNITS MEET COMPLIANCE GUIDELINES OF BOTH THE APARTMENT DESIGN GUIDE AND ACCESSIBILITY CONTROLS

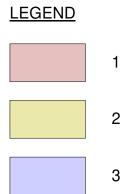

- 1 BEDROOM UNIT
- 2 BEDROOM UNIT
- 3 BEDROOM UNIT

NatHERS Thermal Performance Specification						
External Walls						
Wall Type	Insulation	Colour	Comments			
AFS	R1.5	Light - SA < 0.475 Throughout				
SA - Solar Absorptance						
		Internal Walls				
Wall Type	Wall Type Insulation Comments					
Hebel	None	Interna	lly in units			
AFS	None	Part	y walls			
		Floors				
Floor Type	Insulation	Com	ments			
Concrete	R1.0	Suspended sla	b over basement			
Concrete	Concrete None Unit below					
		Ceilings				
Ceiling Type	Ceiling Type Insulation Comments					
Plasterboard None Throughout						
Any insulation loss due to downlights ha	Any insulation loss due to downlights has not been modelled in this assessment. A sealed exhaust fan has been included in every kitchen, bathroom, ensuite and laundry.					
		Roof				
Roof Type	Insulation	Colour	Comments			
	R1.3 foil faced					
Metal	blanket	Med - SA 0.475 - 0.7	Throughout			
		SA - Solar Absorptance				
		Glazing				
Glazing & Frame Type	U-Value	SHGC	Comments			
Single Clear Aluminium	6.7	0.57	Awning windows			
Single Clear Aluminium	6.7	0.7	Sliding and fixed glazing throughout except as below			
Circula I and E Change Alternative		0.44	Glazing in units 15, 19, 34, 38, 53, 57, 72, 76, 91, 95, 110, 114, 129 & 133			
Single Low E Clear Aluminium	5.6	0.41	76, 91, 95, 110, 114, 129 & 155			
Shulleht True o	U-Value	Skylights SHGC	Comments			
Skylight Type						
na na	na	na	na			
U and SHGC values are based on the		dows Set. Glazing systems to be installed m e ± 10% of the above specified values.	ust nave an equal or lower U value and a			

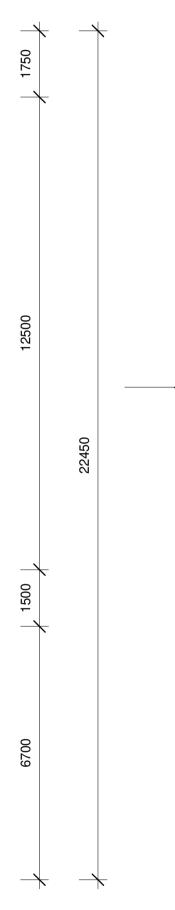

∕в∖

DA43

A	09.05.2017	DEVELOPMENT APPLICATION SET
NO.	DATE.	DETAILS.
Amendr		

Stephen Jones Associates

- p. 02 9977 2240
- . m. 0418 866 784
- sj@stephenjonesassociates.com е. w. www.stephenjonesassociates.com

Registered Architect Gary Finn No. 5774 (NSW)

Project: SENIORS LIVING DEVELOPMENT LOT 1, DP 780801 WINDWARD WAY, MILTON NSW 2538

Drawing: **APARTMENTS – TYPICAL GROUND** FLOOR PLAN

This drawing is copyright and must not be retained, copied or used without consent of designer.

Scale: 1:100 @A1 Job No: 1516 Drawing No: Date: 09.05.2017 Drawn: SJ

DA39






FLOOR AREA: 670 SQM

NOTE: ALL UNITS MEET COMPLIANCE GUIDELINES OF BOTH THE APARTMENT DESIGN GUIDE AND ACCESSIBILITY CONTROLS


A DA43

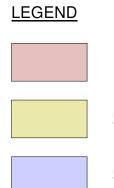

- 1 BEDROOM UNIT
- 2 BEDROOM UNIT
- 3 BEDROOM UNIT

NatHERS Thermal Performance Specification						
External Walls						
Wall Type	Wall Type Insulation Colour Comments					
AFS	R1.5	Light - SA < 0.475 Throughout				
SA - Solar Absorptance						
		Internal Walls				
Wall Type	Wall Type Insulation Comments					
Hebel	None	Interna	lly in units			
AFS	None	Part	y walls			
		Floors				
Floor Type	Insulation	Com	ments			
Concrete	R1.0	Suspended sla	b over basement			
Concrete	None	Unit	below			
		Ceilings				
Ceiling Type Insulation Comments						
Plasterboard	rboard None Throughout					
Any insulation loss due to downlights h	as not been modelled	in this assessment. A sealed exhaust fan h ensuite and laundry.	as been included in every kitchen, bathroom,			
		Roof				
Roof Type	Insulation	Colour	Comments			
	R1.3 foil faced					
Metal	blanket	Med - SA 0.475 - 0.7	Throughout			
		SA - Solar Absorptance				
	1	Glazing				
Glazing & Frame Type	U-Value	SHGC	Comments			
Single Clear Aluminium	6.7	0.57	Awning windows Sliding and fixed glazing throughout			
Single Clear Aluminium	6.7	0.7	except as below			
Single Clear Aluminum	0.7	0.7	Glazing in units 15, 19, 34, 38, 53, 57, 72,			
Single Low E Clear Aluminium	5.6	0.41	76, 91, 95, 110, 114, 129 & 133			
		Skylights				
Skylight Type	U-Value	SHGC	Comments			
na	na	na	na			
U and SHGC values are based on t		dows Set. Glazing systems to be installed m ie ± 10% of the above specified values.	ust have an equal or lower U value and a			



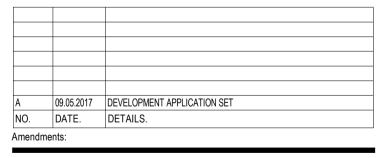

Stephen Jones Associates

- p. 02 9977 2240
- m. 0418 866 784
- sj@stephenjonesassociates.com е.
- w. www.stephenjonesassociates.com

Registered Architect Gary Finn No. 5774 (NSW)

Project: SENIORS LIVING DEVELOPMENT LOT 1, DP 780801 WINDWARD WAY, MILTON NSW 2538

Drawing: **APARTMENTS – TYPICAL LEVEL 1** FLOOR PLAN

Scale: 1 : 100 @A1 Job No: 1516 Drawing No: Date: 09.05.2017









LEVEL 2 / 1:100

FLOOR AREA: 470 SQM


16000

A DA43

13200


3050 \rightarrow

NOTE: ALL UNITS MEET COMPLIANCE GUIDELINES OF BOTH THE APARTMENT DESIGN GUIDE AND ACCESSIBILITY CONTROLS

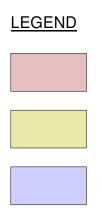

- 1 BEDROOM UNIT
- 2 BEDROOM UNIT
- 3 BEDROOM UNIT

NatHERS Thermal Performance Specification						
		External Walls				
Wall Type	Insulation	Colour Comments				
AFS	R1.5	Light - SA < 0.475 Throughout				
SA - Solar Absorptance						
		Internal Walls				
Wall Type Insulation Comments						
Hebel	None	Interna	lly in units			
AFS	None	Part	y walls			
		Floors				
Floor Type	Insulation	Com	uments			
Concrete	R1.0	Suspended sla	b over basement			
Concrete	None	Unit	below			
		Ceilings				
Ceiling Type	Insulation	Comments				
Plasterboard	Plasterboard None Throughout					
Any insulation loss due to downlights	has not been modelled	in this assessment. A sealed exhaust fan h ensuite and laundry.	as been included in every kitchen, bathroom,			
		Roof				
Roof Type	insulation	Colour	Comments			
M / 1	R1.3 foil faced					
Metal	blanket	Med - SA 0.475 - 0.7 SA - Solar Absorptance	Throughout			
		,				
	1	Glazing				
Glazing & Frame Type	U-Value	SHGC	Comments			
Single Clear Aluminium	6.7	0.57	Awning windows Sliding and fixed glazing throughout			
Single Clear Aluminium	6.7	0.7	except as below			
			Glazing in units 15, 19, 34, 38, 53, 57, 72,			
Single Low E Clear Aluminium	5.6	0.41	76, 91, 95, 110, 114, 129 & 133			
		Skylights	I			
Skylight Type	U-Value	SHGC	Comments			
na	na	na	na			
U and SHGC values are based on		dows Set. Glazing systems to be installed n ie ± 10% of the above specified values.	nust have an equal or lower U value and a			

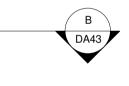

A	09.05.2017	DEVELOPMENT APPLICATION SET
NO.	DATE.	DETAILS.

Stephen Jones Associates

- p. 02 9977 2240 m. 0418 866 784
- e. sj@stephenjonesassociates.comw. www.stephenjonesassociates.com

Registered Architect Gary Finn No. 5774 (NSW)


Project: SENIORS LIVING DEVELOPMENT LOT 1, DP 780801 WINDWARD WAY, MILTON NSW 2538

Drawing: APARTMENTS – TYPICAL LEVEL 2 FLOOR PLAN

Scale: 1:100 @A1 Job No: 1516 Drawing No: Date: 09.05.2017





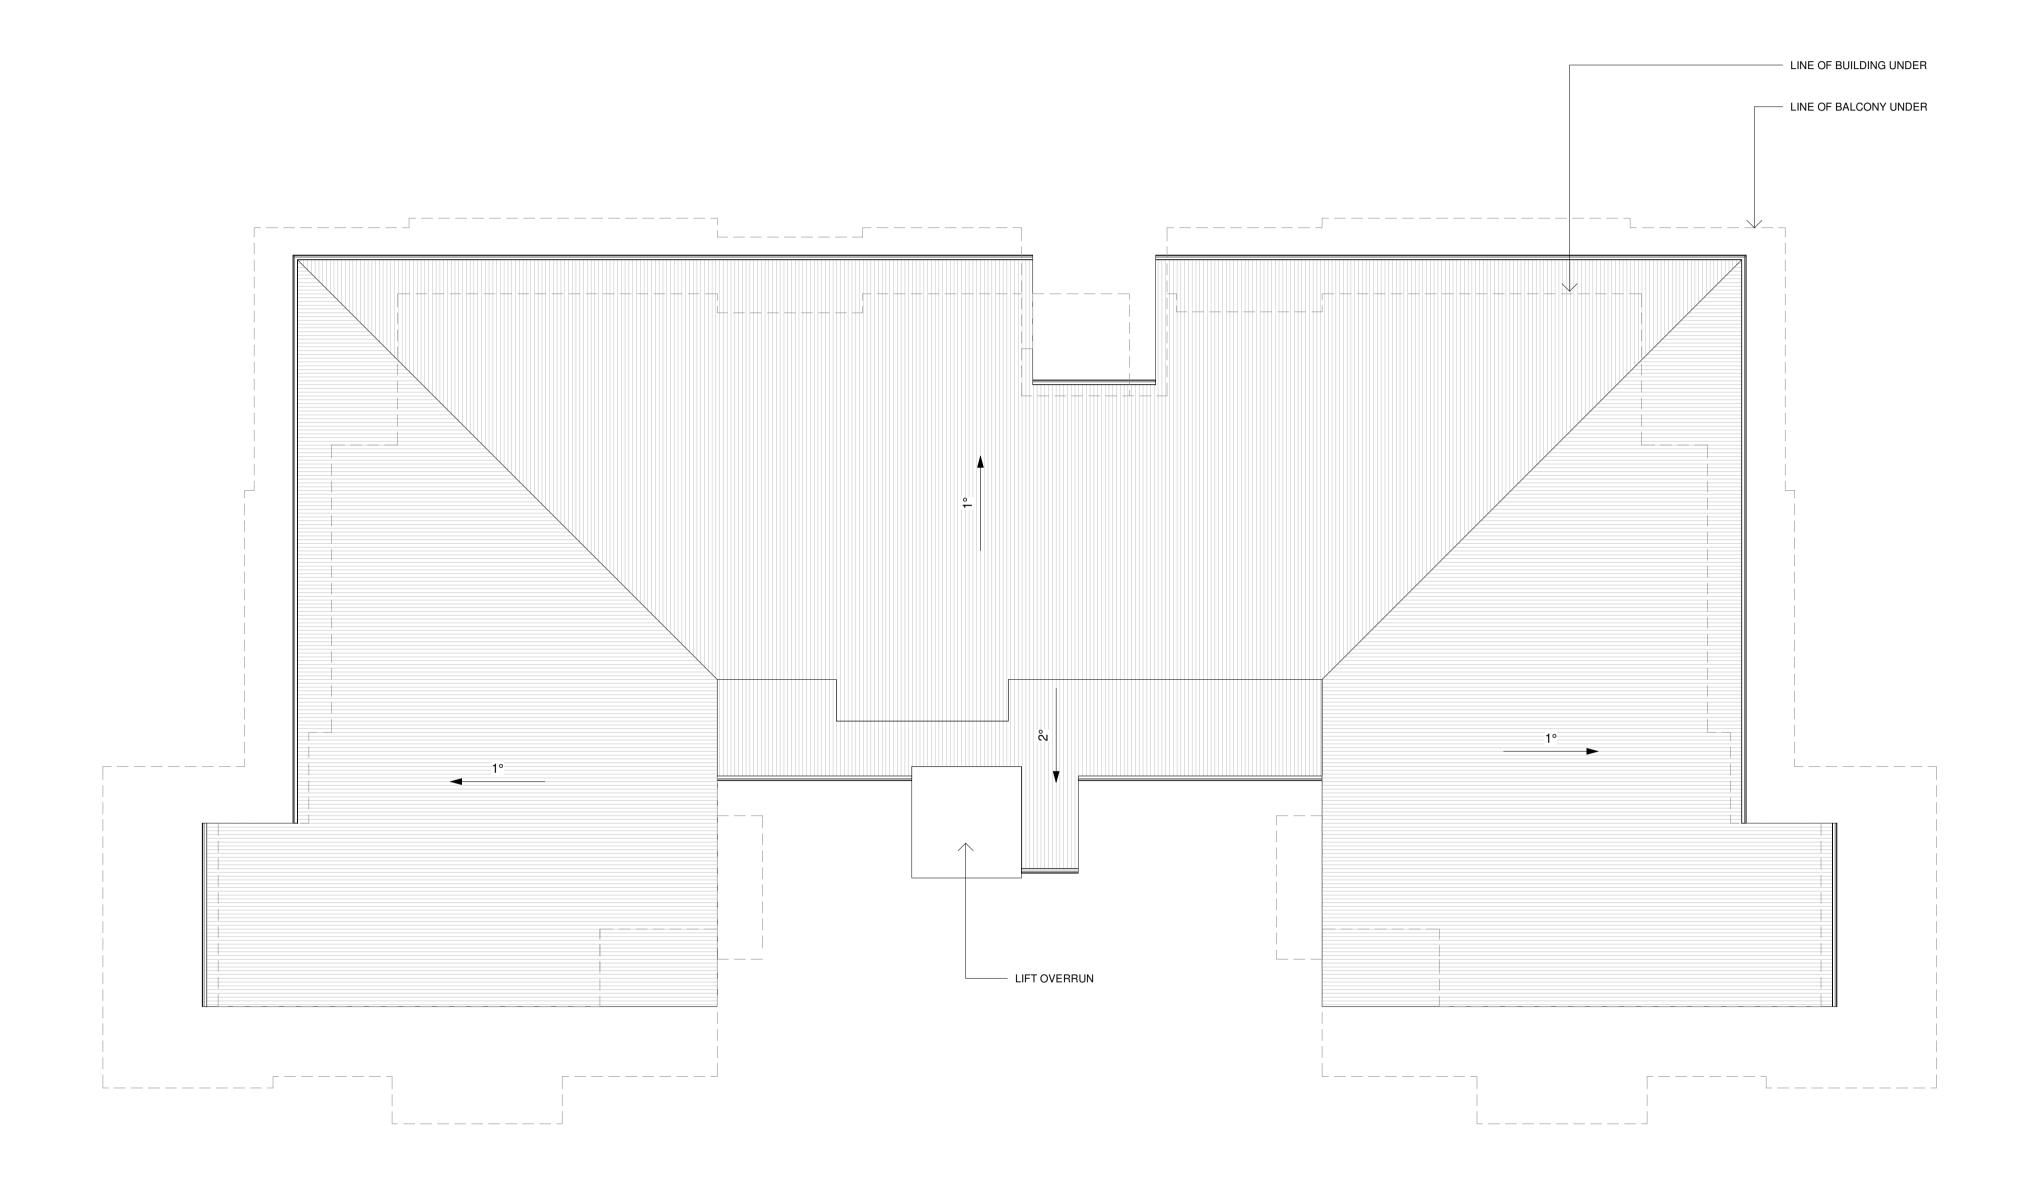



NOTE: ALL UNITS MEET COMPLIANCE GUIDELINES OF BOTH THE APARTMENT DESIGN GUIDE AND ACCESSIBILITY CONTROLS

	Nathers 1	Thermal Performance Specification				
		External Walls				
Wall Type	Insulation	Colour Comments				
AFS	R1.5	Light - SA < 0.475	Throughout			
		SA - Solar Absorptance				
		Internal Walls				
Wall Type	Insulation	Cor	nments			
Hebel	None	Interna	ally in units			
AFS	None	Par	ty walls			
		Floors				
Floor Type	Insulation	Cor	nments			
Concrete	R1.0	Suspended sl	ab over basement			
Concrete	None	None Unit below				
		Ceilings				
Ceiling Type	Insulation	Cor	nments			
Plasterboard None Throughout						
		ensuite and laundry. Roof				
Roof Type	Insulation	Colour	Comments			
Metal	R1.3 foil faced blanket	Med - SA 0.475 - 0.7	Throughout			
		SA - Solar Absorptance				
		Glazing				
Glazing & Frame Type	U-Value	SHGC	Comments			
Single Clear Aluminium	6.7	0.57	Awning windows			
Single Clear Aluminium	6.7	0.7	Sliding and fixed glazing throughout except as below			
Single Low E Clear Aluminium	5.6	0.41	Glazing in units 15, 19, 34, 38, 53, 57, 72 76, 91, 95, 110, 114, 129 & 133			
		Skylights				
Skylight Type	U-Value	SHGC	Comments			
na	na	na	na			
U and SHGC values are based on t		ows Set. Glazing systems to be installed i ± 10% of the above specified values.	nust have an equal or lower U value and a			

NatHERS Thermal Performance Specification

А	09.05.2017	DEVELOPMENT APPLICATION SET
NO.	DATE.	DETAILS.
Amendr	nents:	

- Stephen Jones Associates

- p. 02 9977 2240 m. 0418 866 784
- e. sj@stephenjonesassociates.comw. www.stephenjonesassociates.com

Registered Architect Gary Finn No. 5774 (NSW)

Project: SENIORS LIVING DEVELOPMENT LOT 1, DP 780801 WINDWARD WAY, MILTON NSW 2538

Drawing: APARTMENTS – TYPICAL ROOF PLAN

Scale: 1 : 100 @A1 Job No: 1516 Drawing No: Date: 09.05.2017










	P			
ρ	и	Ţ		
ρ	и			P
				_ _



NOTE: THESE DRAWINGS ARE OF TYPICAL APARTMENT BLOCK. NATURAL GROUND LINE, PROPOSED GROUND LINE AND HEIGHT LINES WILL VARY FOR EACH. PLEASE REFER TO DA08 & **DA50**

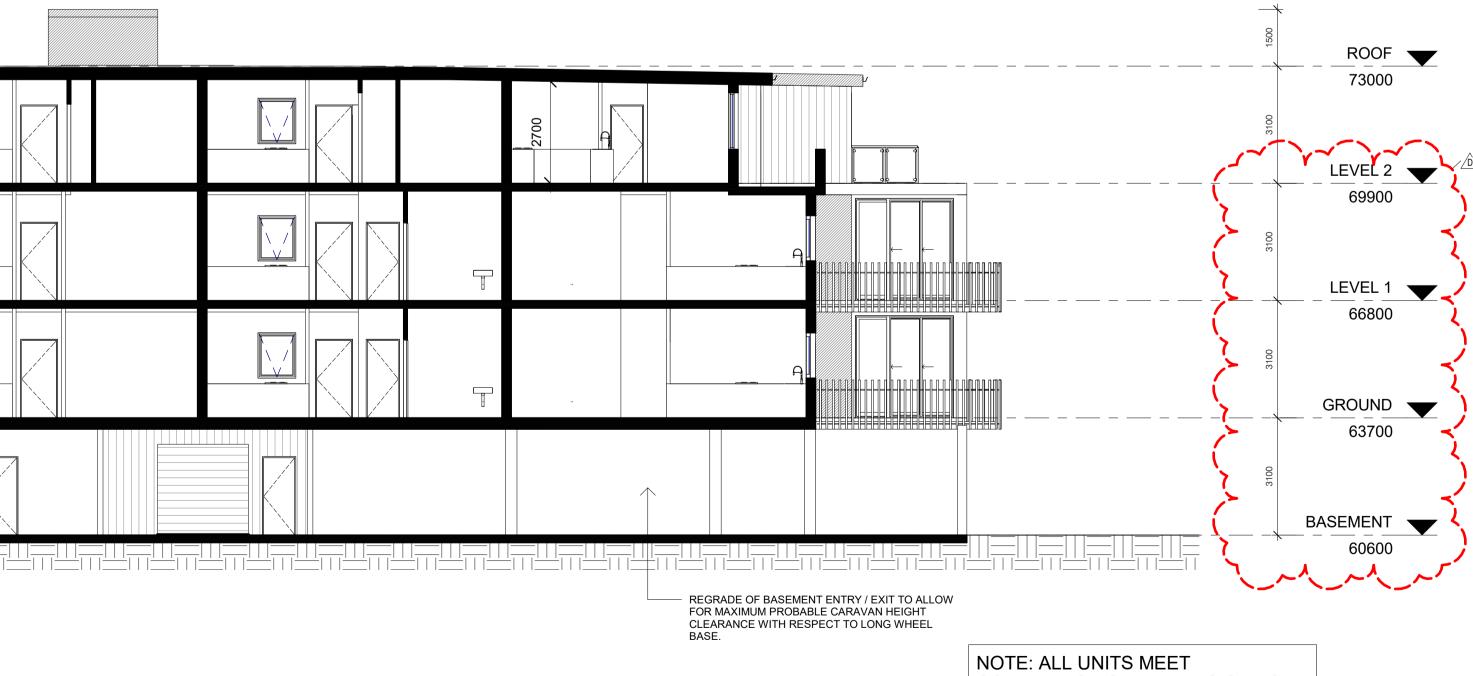

COMPLIANCE GUIDELINES OF BOTH THE APARTMENT DESIGN GUIDE AND ACCESSIBILITY CONTROLS

CONSTRUCTION NOTES

BASEMENT INCL. SUPPORT COLUMNS AND APARTMENTS FLOORS TO BE CONCRETE WITH AFS OR SIMILAR STRUCTURAL WALLS TO ABOVE GROUND

NON STRUCTURAL WALLS TO HEBEL ROOF TO BE STEEL FRAMED WITH PDR. COATED CLIPLOCK ROOFING INCL. UPPER FLOOR EXTERAL WALL CLADDING

REFER TO BASIX/NATHERS FOR ENERGY AND SUSTAINABILITY COMMITMENTS INCLUDING 3000 LTR WATER STORAGE ADJACENT LIFT SHAFT

POOL TO BE STANDARD CONCRETE CONSTRUCTION TO ENG DETAILS WITH METAL PERIMETER STRUCTURE OVER ON 100 SQ COLUMNS TO HOUSE ADJAUSTABLE VERGOLA. PULL DOWN PLASTIC ZIP UP SIDES WILL FACILITATE ALL WEATHER CONDITIONS



D	18.08.2020	ADDITIONAL INFORMATION	
С	27.06.2020	ADDITIONAL INFORMATION	
В	08.06.2017	ADDITIONAL INFORMATION	
А	09.05.2017	DEVELOPMENT APPLICATION SET	
NO.	DATE.	DETAILS.	
Amendr	ments:		

Stephen Jones Associates


- p. 02 9977 2240
- m. 0418 866 784
- sj@stephenjonesassociates.com е. w. www.stephenjonesassociates.com


Registered Architect Gary Finn No. 5774 (NSW)

SENIORS LIVING DEVELOPMENT LOT 1, DP 780801 WINDWARD WAY, MILTON NSW 2538

Drawing: **APARTMENTS – SECTIONS**

Scale: 1:100 @A1 Job No: 1516 Drawing No: Date: 18.08.2020 **DA43** Drawn: SJ This drawing is copyright and must not be retained, copied or used without consent of designer.

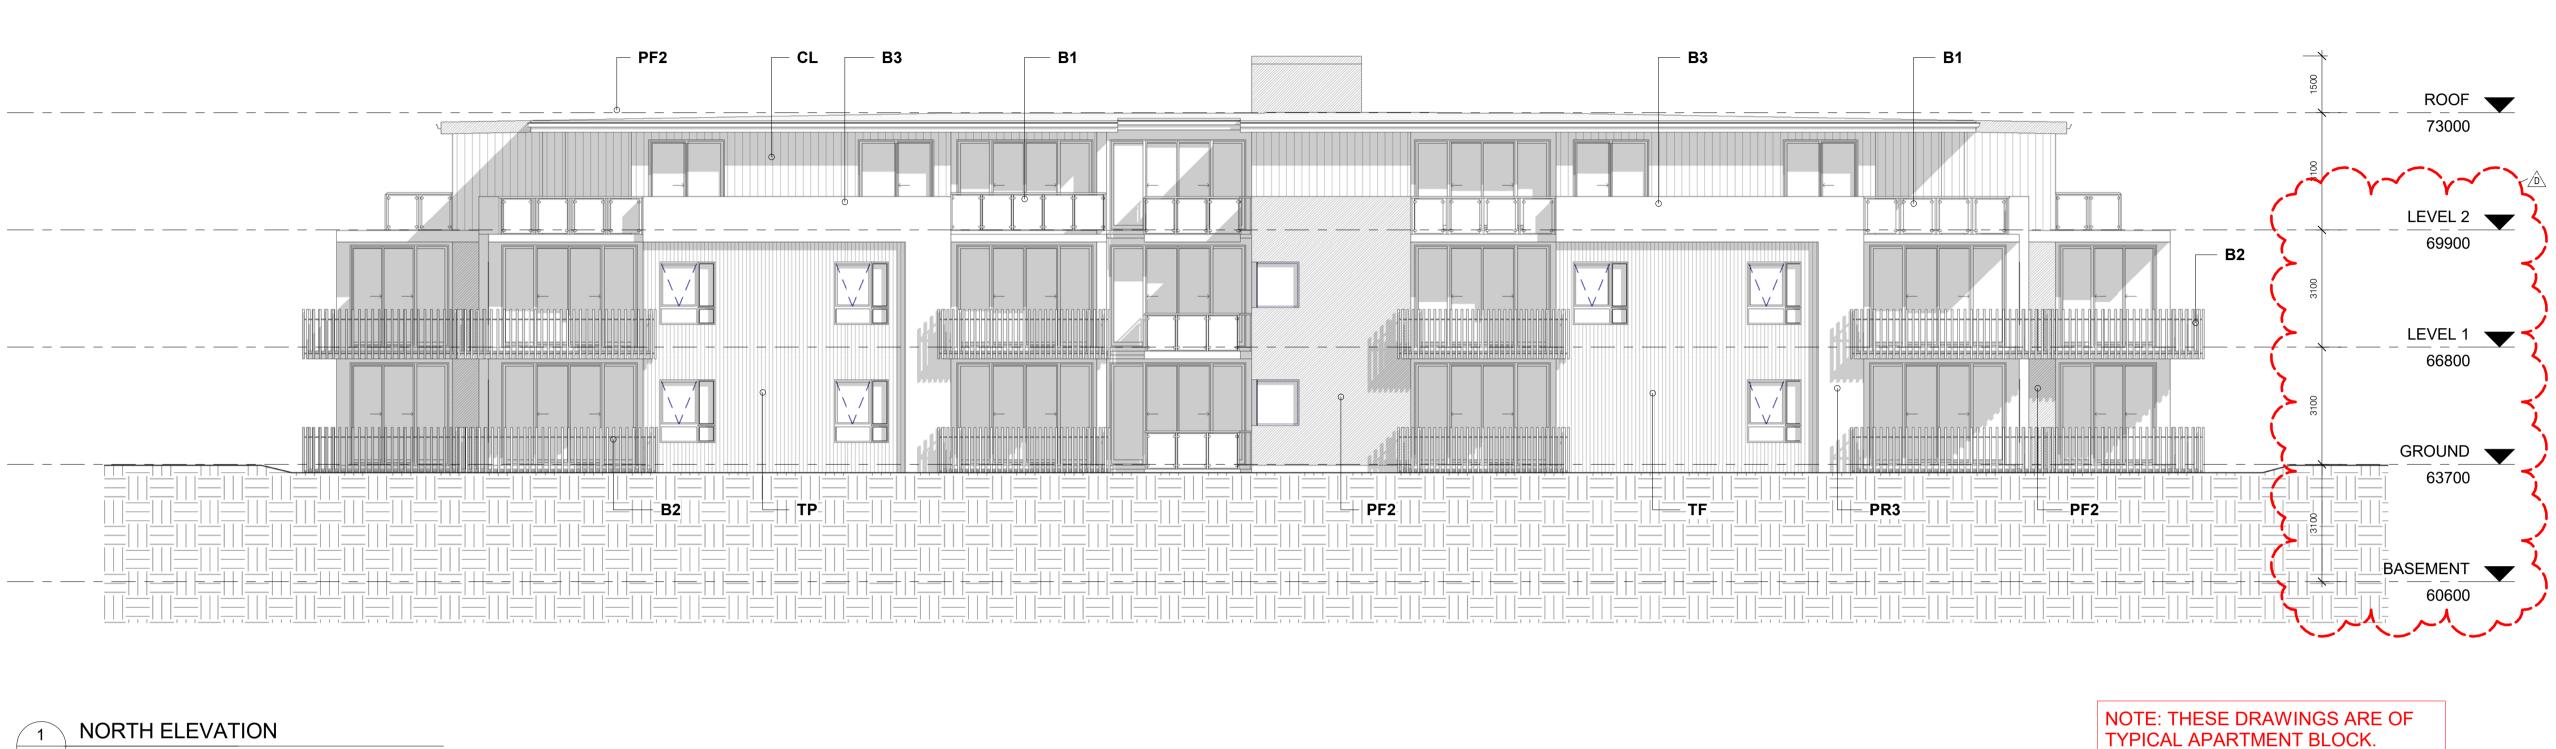

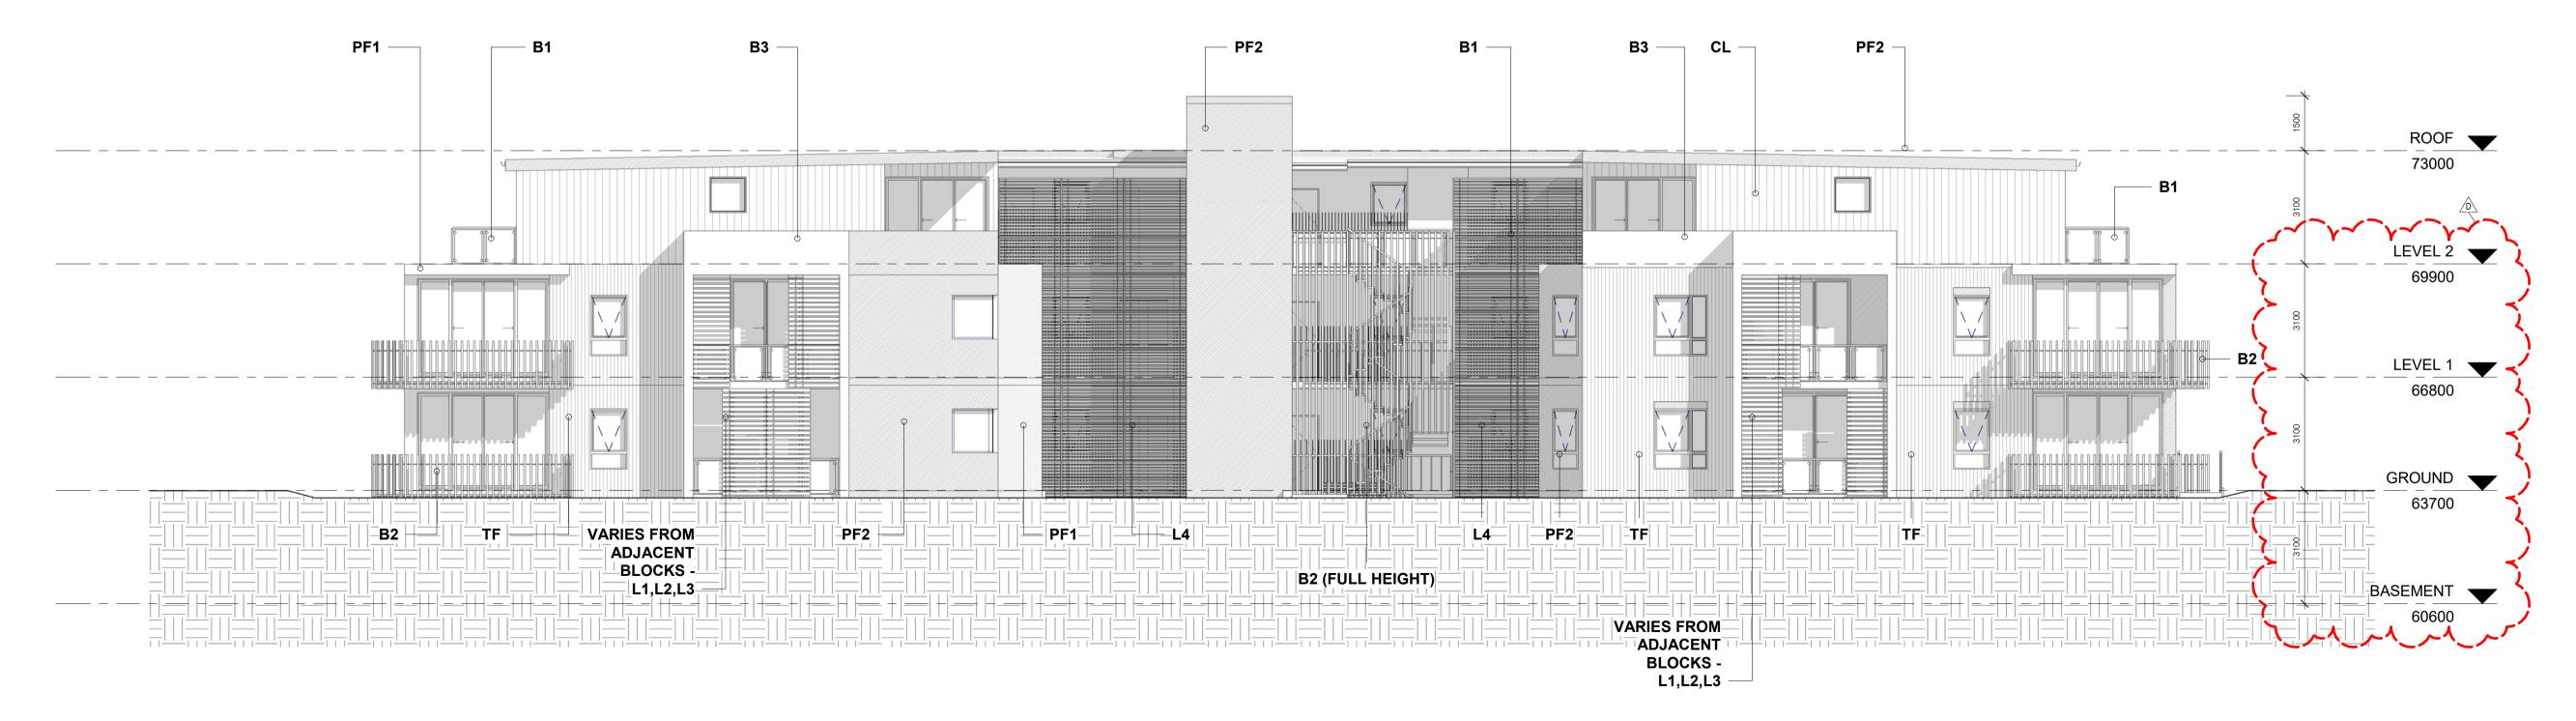

SOUTH ELEVATION ∕ 2 ∖ 1 : 100

1:100

NATURAL GROUND LINE, PROPOSED GROUND LINE AND HEIGHT LINES WILL VARY FOR EACH. PLEASE REFER TO DA08 & **DA50**



SCHEDULE OF FINISHES

AF - ALUMINIUM FRAMED SLIDING WINDOWS -WOODLAND GREY AFA - ALUMINIUM FRAMED AWNING WINDOWS -WOODLAND GREY AFSD - ALUMINIUM SLIDING DOOR -WOODLAND GREY

CL - CLIPLOCK 700HS METAL ROOF -WOODLAND GREY **TF** - NATURAL TIMBER FINISH -WEATHERTEX

PF1 - PAINT FINISH RENDERED MASONRY BROADWALL, AC SHEETING - LIGHT GREY **PF2** - PAINT FINISH FASCIA BOARD AND GUTTER AND 150 DIA HALF ROUND GUTTER -WOODLAND GREY **PR3** - PAINT FINISH BALUSTRADE AND SURROUND - WHITE

(PF 1,2 & PR 3 TO INC. CONTRAST TO ADJACENT BLOCKS)

B1 - POST AND RAIL / GLASS PANEL BALUSTRADE - LIGHT GREY **B2** - VERTICAL METAL 50MM SQ. RODS ON FRAME PROUD OF SOFFIT - LIGHT GREY **B3** - MASONRY - PAINT FINISH RENDERED -WHITE

L1 - POWDERCOATED METAL LOUVRES - DIRTY YELLOW

L2 - POWDERCOATED METAL LOUVRES - LIGHT GREY

L3 - POWDERCOATED METAL LOUVRES -TIMBER BROWN L4 - POWDERCOATED METAL LOUVRES - LIGHT GREY

NOTE - LOUVRE COLOR TYPES (X4) TO BE APPLIED CONSECUTIVELY TO APARTMENT BLOCKS

CONSTRUCTION NOTES

BASEMENT INCL. SUPPORT COLUMNS AND APARTMENTS FLOORS TO BE CONCRETE WITH AFS OR SIMILAR STRUCTURAL WALLS TO ABOVE GROUND

NON STRUCTURAL WALLS TO HEBEL ROOF TO BE STEEL FRAMED WITH PDR. COATED CLIPLOCK ROOFING INCL. UPPER FLOOR EXTERAL WALL CLADDING

REFER TO BASIX/NATHERS FOR ENERGY AND SUSTAINABILITY COMMITMENTS INCLUDING 3000 LTR WATER STORAGE ADJACENT LIFT SHAFT

POOL TO BE STANDARD CONCRETE CONSTRUCTION TO ENG DETAILS WITH METAL PERIMETER STRUCTURE OVER ON 100 SQ COLUMNS TO HOUSE ADJAUSTABLE VERGOLA. PULL DOWN PLASTIC ZIP UP SIDES WILL FACILITATE ALL WEATHER CONDITIONS

D	18.08.2020	ADDITIONAL INFORMATION
С	27.06.2020	ADDITIONAL INFORMATION
В	08.06.2017	ADDITIONAL INFORMATION
A	09.05.2017	DEVELOPMENT APPLICATION SET
NO.	DATE.	DETAILS.

Stephen Jones Associates


- p. 02 9977 2240
- m. 0418 866 784
- sj@stephenjonesassociates.com е. w. www.stephenjonesassociates.com

Registered Architect Gary Finn No. 5774 (NSW)


SENIORS LIVING DEVELOPMENT LOT 1, DP 780801 WINDWARD WAY, MILTON NSW 2538

APARTMENTS – ELEVATIONS 1

Scale: 1:100 @A1 Job No: 1516 Drawing No: Date: 18.08.2020 **DA44** Drawn: SJ This drawing is copyright and must not be retained, copied or used without consent of designer.

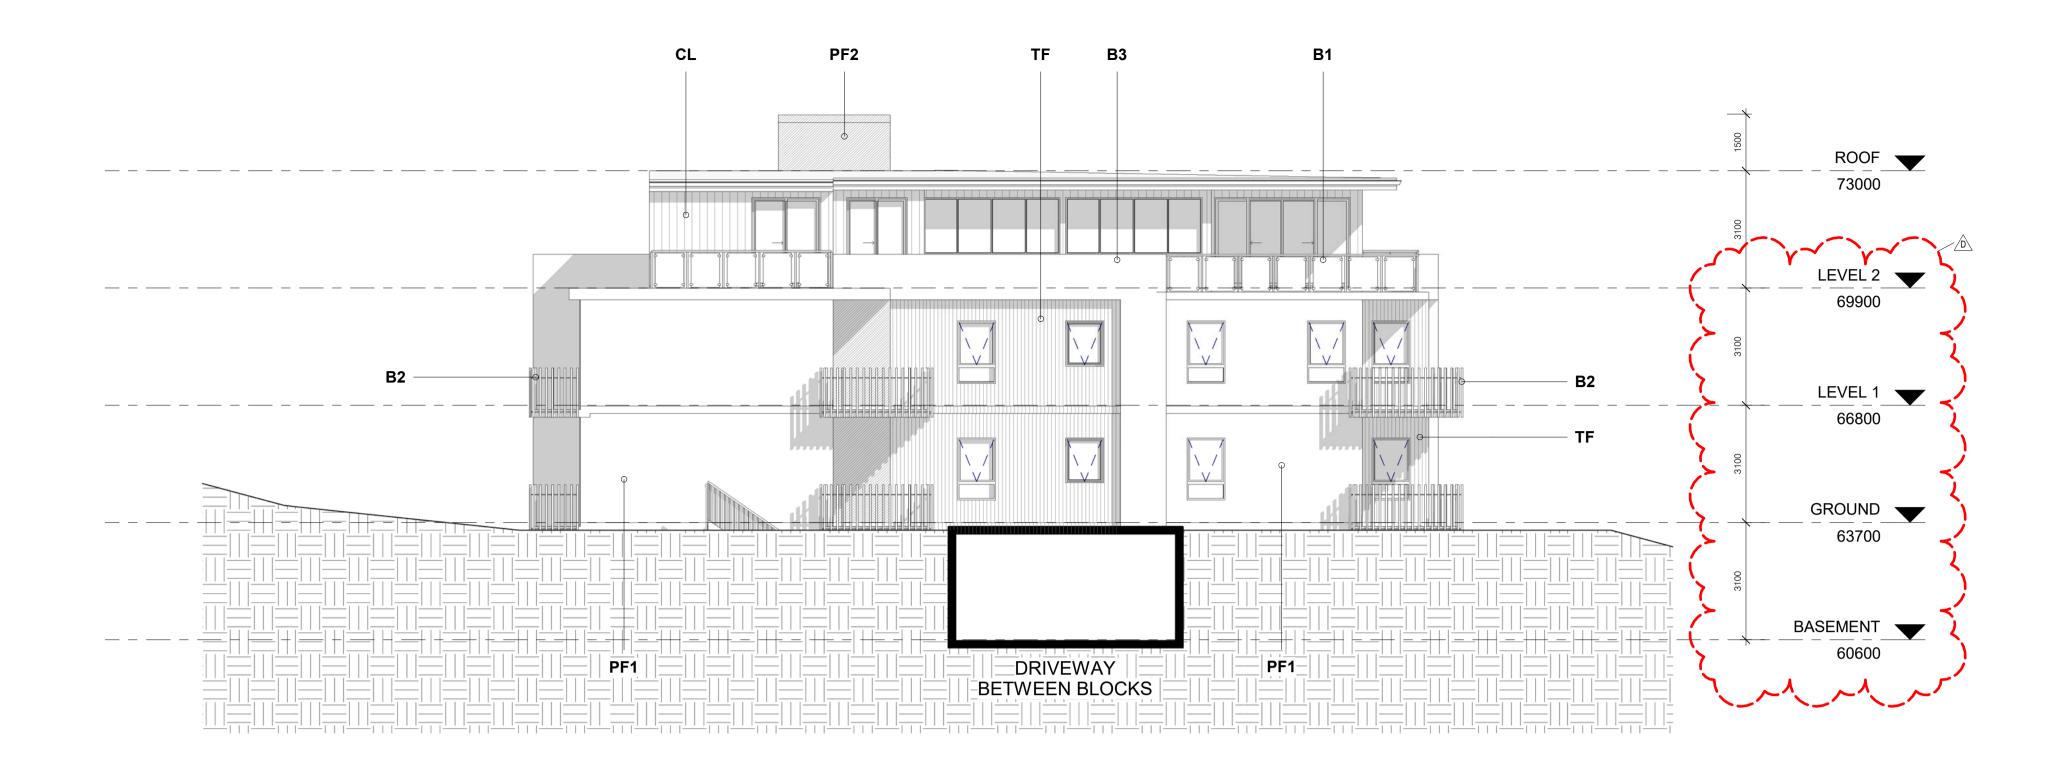



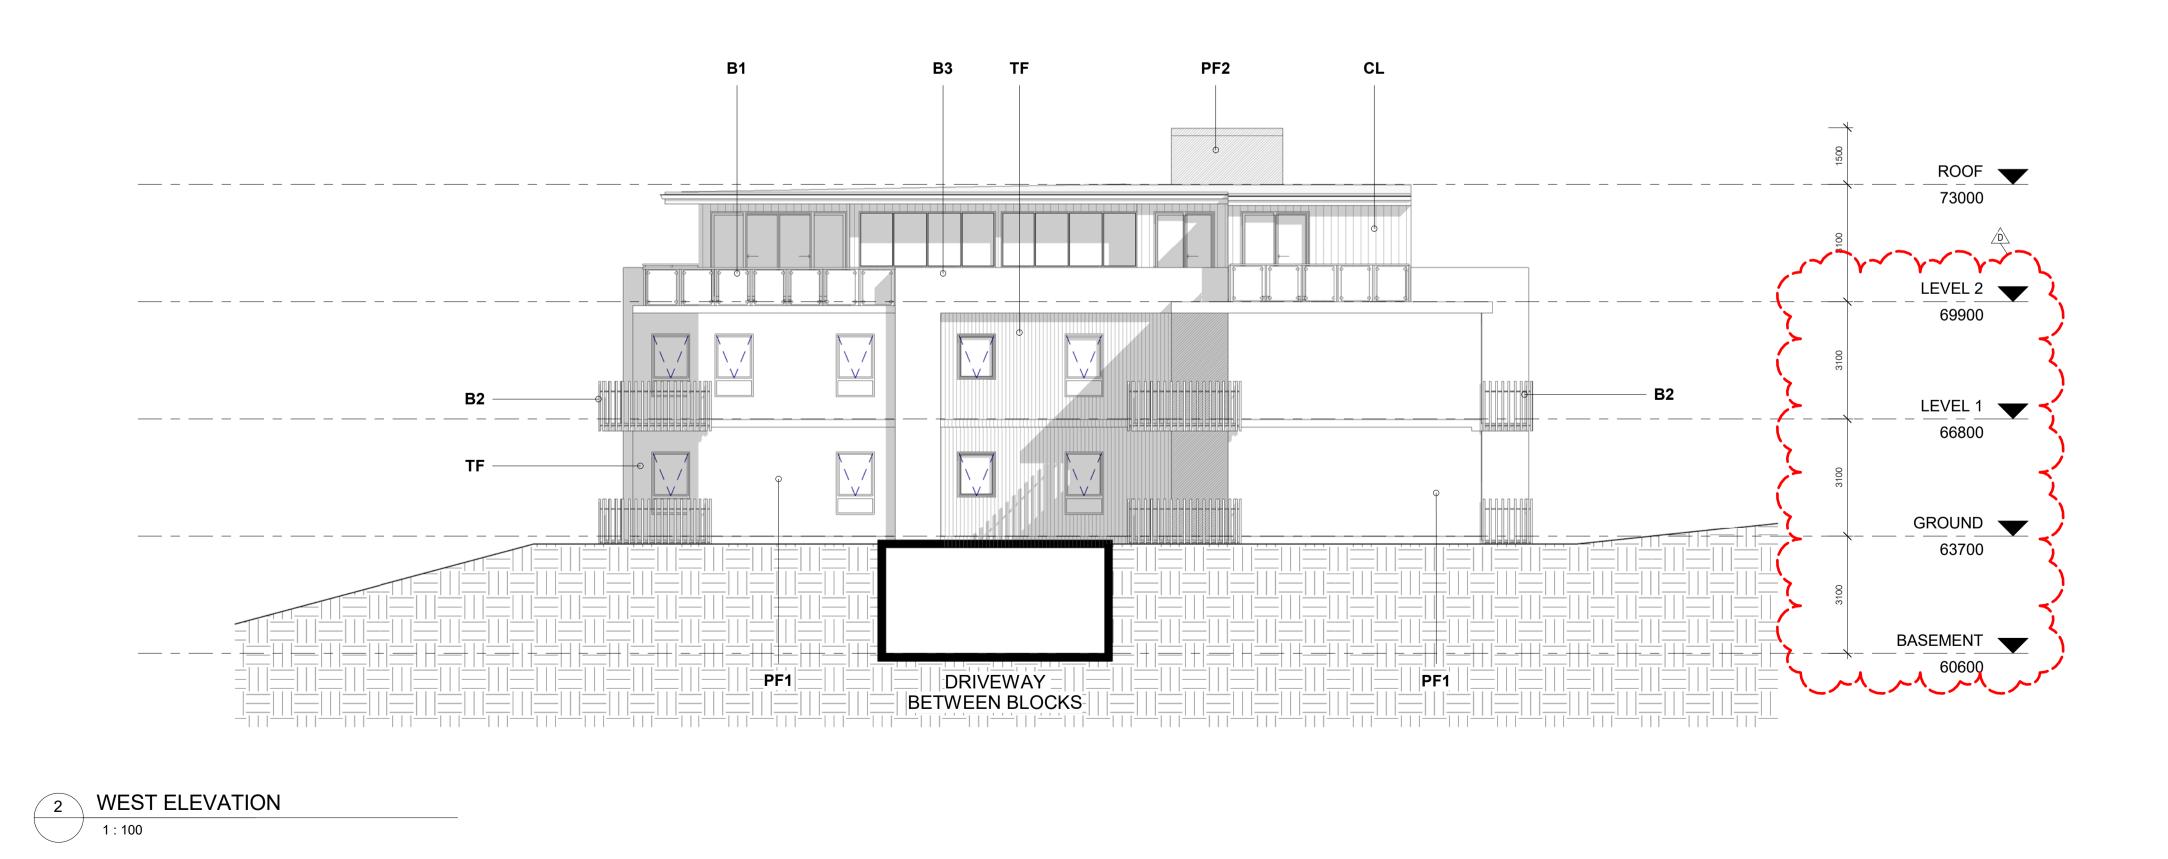

NOTE: THESE DRAWINGS ARE OF TYPICAL APARTMENT BLOCK. NATURAL GROUND LINE, PROPOSED GROUND LINE AND HEIGHT LINES WILL VARY FOR EACH. **PLEASE REFER TO DA08 & DA50** AF - ALUMINIUM FRAMED SLIDING WINDOWS -WOODLAND GREY
AFA - ALUMINIUM FRAMED AWNING WINDOWS -WOODLAND GREY
AFSD - ALUMINIUM SLIDING DOOR -WOODLAND GREY

CL - CLIPLOCK 700HS METAL ROOF -WOODLAND GREY TF - NATURAL TIMBER FINISH -WEATHERTEX

PF1 - PAINT FINISH RENDERED MASONRY BROADWALL, AC SHEETING - LIGHT GREY **PF2** - PAINT FINISH FASCIA BOARD AND GUTTER AND 150 DIA HALF ROUND GUTTER -WOODLAND GREY **PR3** - PAINT FINISH BALUSTRADE AND SURROUND - WHITE

(PF 1,2 & PR 3 TO INC. CONTRAST TO ADJACENT BLOCKS)

B1 - POST AND RAIL / GLASS PANEL
BALUSTRADE - LIGHT GREY
B2 - VERTICAL METAL 50MM SQ. RODS ON
FRAME PROUD OF SOFFIT - LIGHT GREY
B3 - MASONRY - PAINT FINISH RENDERED - WHITE

L1 - POWDERCOATED METAL LOUVRES - DIRTY YELLOW L2 - POWDERCOATED METAL LOUVRES - LIGHT

GREY L3 - POWDERCOATED METAL LOUVRES -

TIMBER BROWN L3 - POWDERCOATED METAL LOUVRES - LIGHT GREY

NOTE - LOUVRE COLOR TYPES (X4) TO BE APPLIED CONSECUTIVELY TO APARTMENT BLOCKS

CONSTRUCTION NOTES

BASEMENT INCL. SUPPORT COLUMNS AND APARTMENTS FLOORS TO BE CONCRETE WITH AFS OR SIMILAR STRUCTURAL WALLS TO ABOVE GROUND

NON STRUCTURAL WALLS TO HEBEL ROOF TO BE STEEL FRAMED WITH PDR. COATED CLIPLOCK ROOFING INCL. UPPER FLOOR EXTERAL WALL CLADDING

REFER TO BASIX/NATHERS FOR ENERGY AND SUSTAINABILITY COMMITMENTS INCLUDING 3000 LTR WATER STORAGE ADJACENT LIFT SHAFT

POOL TO BE STANDARD CONCRETE CONSTRUCTION TO ENG DETAILS WITH METAL PERIMETER STRUCTURE OVER ON 100 SQ COLUMNS TO HOUSE ADJAUSTABLE VERGOLA. PULL DOWN PLASTIC ZIP UP SIDES WILL FACILITATE ALL WEATHER CONDITIONS

D	18.08.2020	ADDITIONAL INFORMATION
С	27.06.2020	ADDITIONAL INFORMATION
В	08.06.2017	ADDITIONAL INFORMATION
A	09.05.2017	DEVELOPMENT APPLICATION SET
NO.	DATE.	DETAILS.
NO. Amendr		DETAILS.

Stephen Jones Associates

- p. 02 9977 2240
- m. 0418 866 784
- e. sj@stephenjonesassociates.comw. www.stephenjonesassociates.com

Registered Architect Gary Finn No. 5774 (NSW)

SENIORS LIVING DEVELOPMENT LOT 1, DP 780801 WINDWARD WAY, MILTON NSW 2538

APARTMENTS – ELEVATIONS 2

 Scale:
 1 : 100
 @A1
 Job No: 1516
 Drawing No:

 Date:
 18.08.2020
 DA45

 Drawn:
 SJ
 SJ

 This drawing is copyright and must not be retained, copied or used without consent of designer.




1 3D View 1









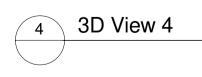

С	18.08.2020	ADDITIONAL INFORMATION
B	27.06.2020	ADDITIONAL INFORMATION
A	09.05.2017	DEVELOPMENT APPLICATION SET
NO.	DATE.	DETAILS.

Stephen Jones Associates

- p. 02 9977 2240 m. 0418 866 784
- e. sj@stephenjonesassociates.com w. www.stephenjonesassociates.com

Registered Architect Gary Finn No. 5774 (NSW)

Project: SENIORS LIVING DEVELOPMENT LOT 1, DP 780801 WINDWARD WAY, MILTON NSW 2538

Drawing: APARTMENTS – PERSPECTIVES 1


@A1 Job No: 1516 Drawing No: Scale: Date: 18.08.2020 **DA46** Drawn: SJ This drawing is copyright and must not be retained, copied or used without consent of designer.







3 3D View 7

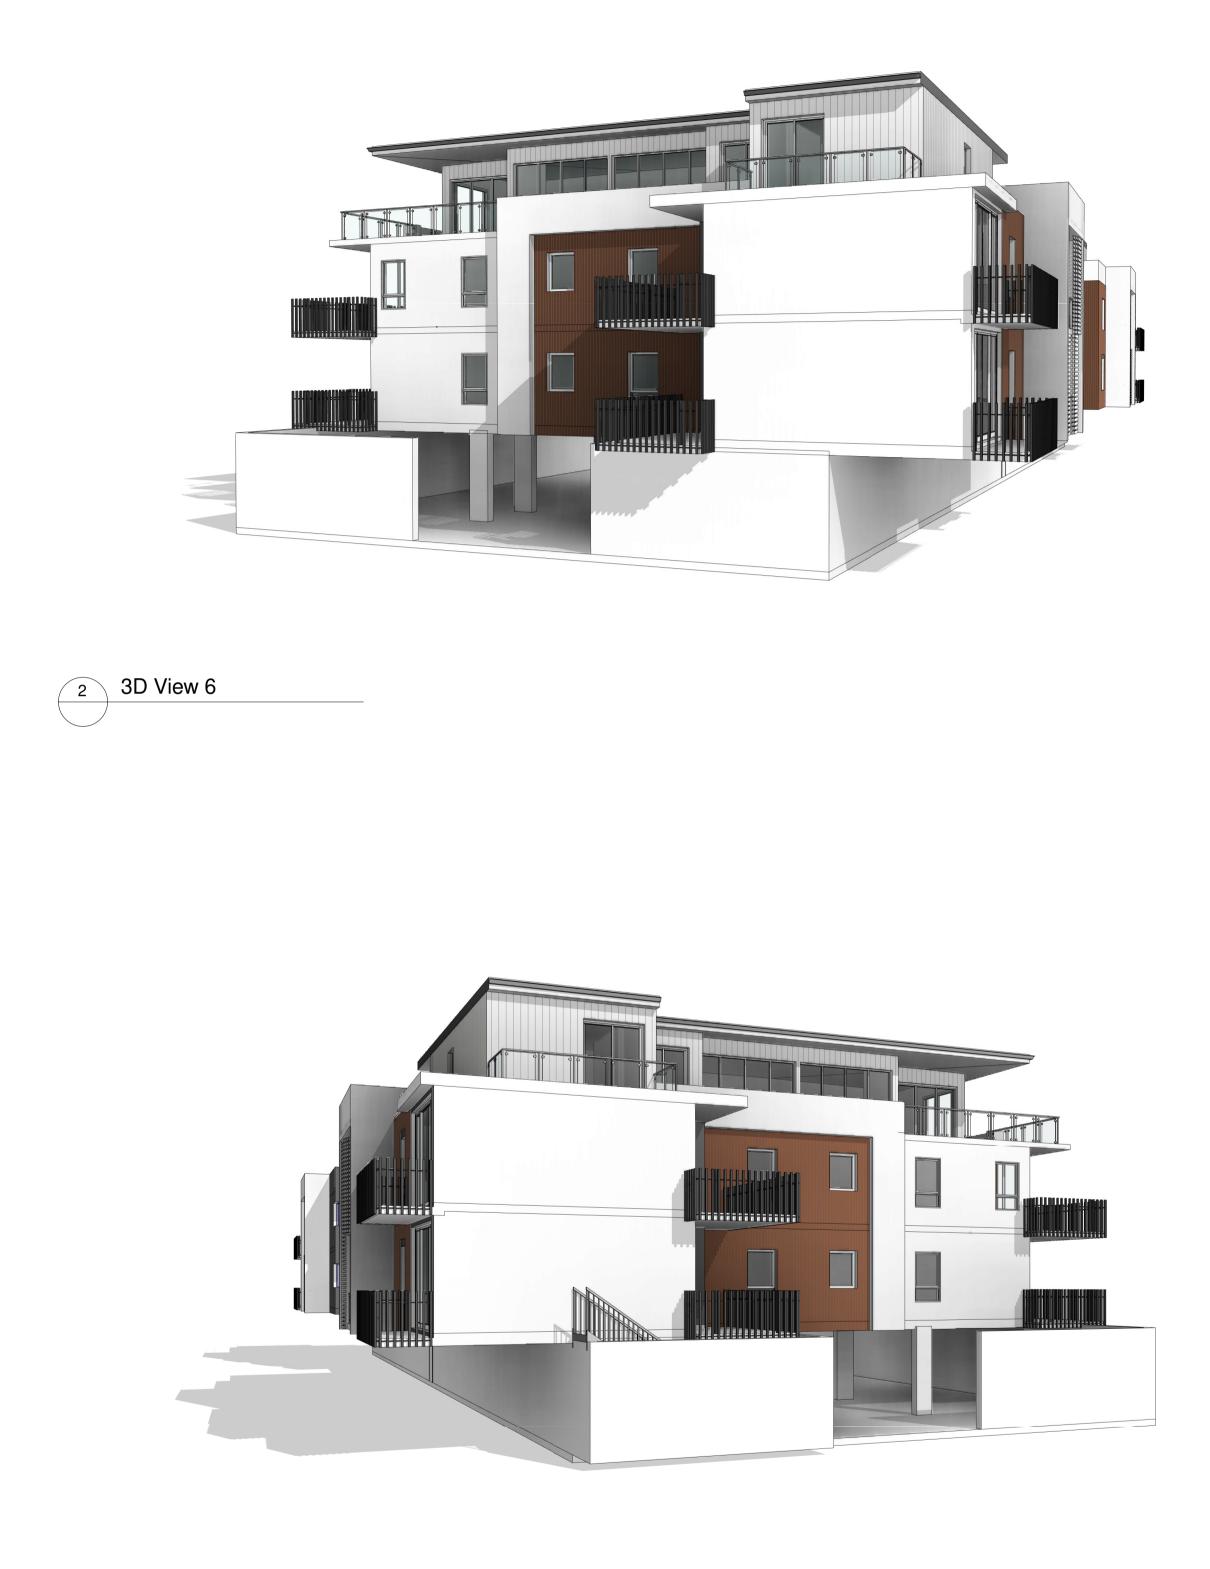

4 3D View 8

 18.08.2020
 ADDITIONAL INFORMATION

 27.06.2020
 ADDITIONAL INFORMATION

 09.05.2017
 DEVELOPMENT APPLICATION SET
 NO. DATE. DETAILS. Amendments:

Stephen Jones Associates

- p. 02 9977 2240 m. 0418 866 784
- e. sj@stephenjonesassociates.comw. www.stephenjonesassociates.com

Registered Architect Gary Finn No. 5774 (NSW)

Project: SENIORS LIVING DEVELOPMENT LOT 1, DP 780801 WINDWARD WAY, MILTON NSW 2538

Drawing: APARTMENTS – PERSPECTIVES 2

@A1 Job No: 1516 Drawing No: Scale: Date: 18.08.2020 **DA47** Drawn: SJ This drawing is copyright and must not be retained, copied or used without consent of designer.